

SRVCE5

MNEK: RUBEN GONZALEZ
PPRESS;
910 W. EXP 83, MISSION, 1X 78572
NYACT #: [EMAIL.

PROJECT FOR:


AMERICAN LEGION POST #93

ADDRESS:

910 W. EXP. 83, MISSION, 1X 78572

# AMERICAN LEGION POST 93

NORTH MCALLEN TOWNSITE

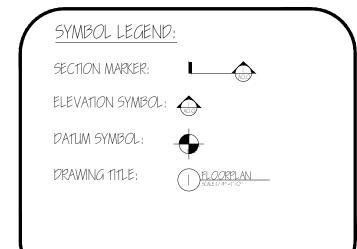

SYPNOSIS;

EXISTING BUILDING; 4,572' 50.FT.


PROPOSED EXPANSION; 1,330' 50.FT.

TOTAL; 5,902' 50.FT.

## SHEET INDEX:


- O.O COVER SHEET
- I.O SITE PLAN
- 2.0 FOUNDATION PLAN
- 2.1 WALL & FOUNDATION DETAILS
- 3.0 DEMOLITION PLAN
- 3.1 FLOOR PLAN
- 4.0 EXTERIOR ELEVATIONS
- 5.0 ROOF PLAN


PROJECT TITLE: AMERICA LEGION POST

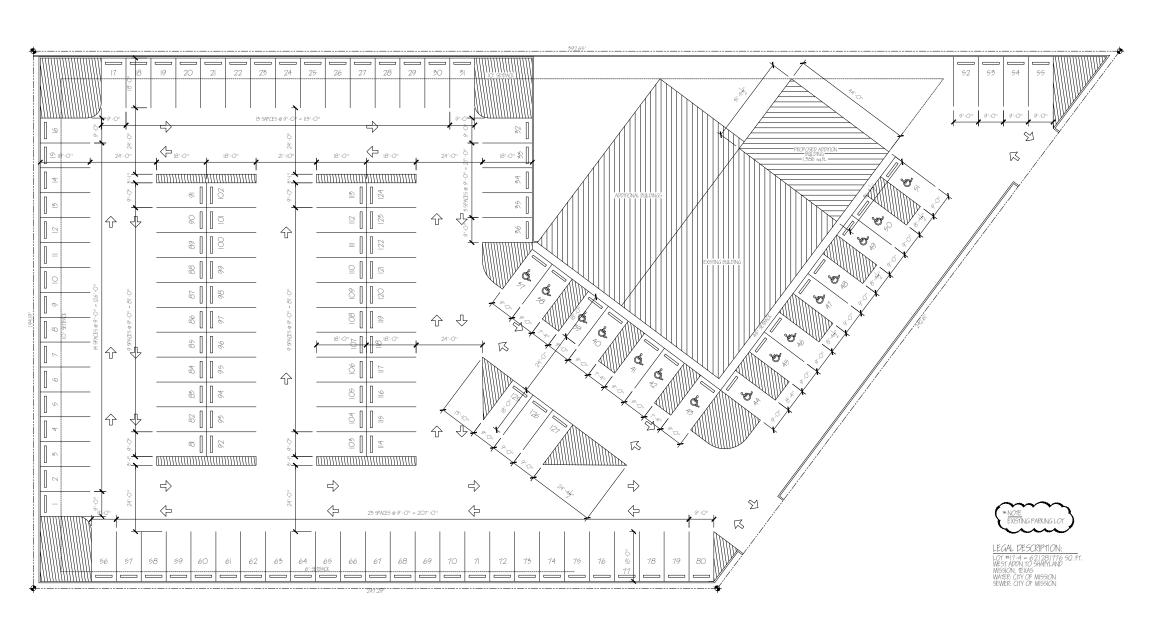




151.95	OWNER; RUBEN GONZALEZ	ADPRESS; 910 W. EXP 83, MISSION, TX 78572	CONTACT #; EMAIL: N/ A
AMERICA LEGION POST 93	DRAWN BY; SIGIFREDO RODRIGUEZ	SCALE;  /8"= '-0"	
PROJECT TITLE;	CONTRACTOR; T.B.A	DATE ; JUNE 12, 2025	

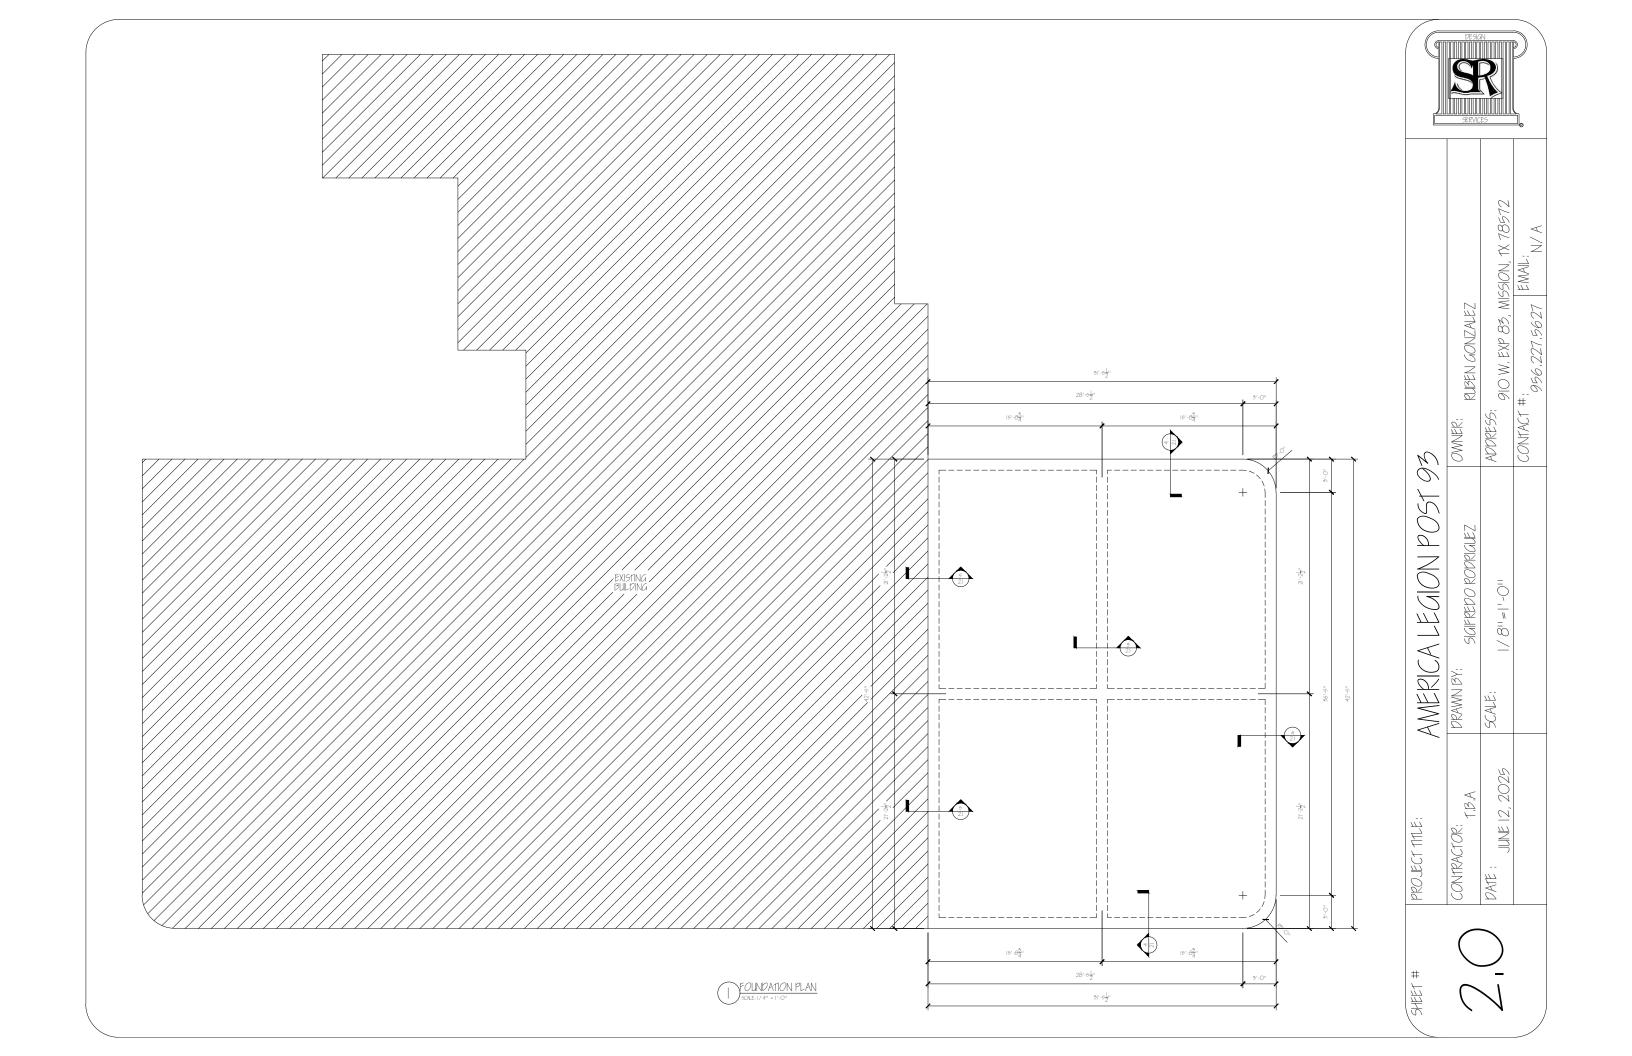


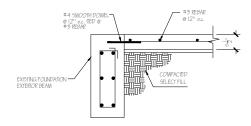


# 5 CONNECTION EXISTING BEAM DETAIL

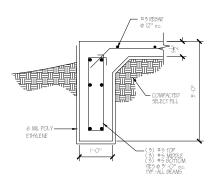

EXTERIOR BEAM DETAIL

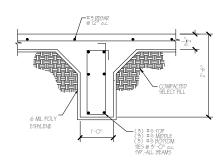



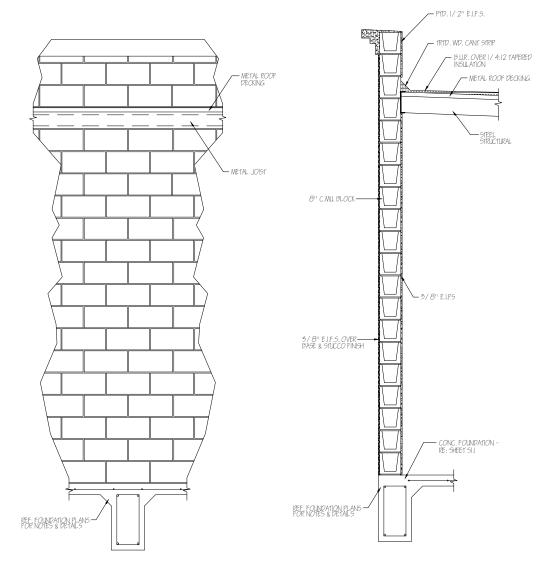



# EXTERIOR WALL SECTION DETAIL

### GENERAL NOTES

#### DESIGN CRITERIA

- I. FOUNDATION DESIGN IS IN ACCORDANCE WITH THE STANDARD BUILDING CODE, IT IS NOT BASED ON ANY SPECIFIC GEOTECHNICAL INVESTIGATION.

#### CONCRETE

- ALL CONCRETE WORK SHALL CONFORM TO THE AMERICAN CONCRETE INSTITUTE SPECIFICATION, A.C.I. #501 AND BUILDING CODE REQUIREMENTS, A.C.I. #518, LATEST EDITION.
- ALL DETAILING, FABRICATION AND ERECTION OF REINFORCING BARS, UNLESS
  OTHERWER NOTED, MUST FOLLOW THE ACL. "MANUAL OF STANDARD
  PRACTICE FOR DETAILING REINFORCED CONCRETE", ACJ. # 515, LATEST
  EDITION.
- 3. CONCRETE SHALL HAVE A MINIMUM COMPRESSION STRENGTH AT 28 DAYS AS FOLLOWS:
- 3000 PSI FOR ALL CONCRETE FOUNDATION COMPONENTS
- A WAXIMUM OF 29% FLYASH MAY BE LEED AS A CEMENT SLESTITUTE AND SHALL CONFORM TO ASTIM CEIB. THE WATER/CEMENT RATIO SHALL NOT EXCEED OLD AND SLUMPS SHALL BE DETEMBEN 4 AND 9 INDES, COORDINATE WITH OWNERS TESTIMA LASORATIORY (1F ONE 15 SELECTED) TO PROVIDE TESTINA AS FER A.C.I.
- 4. REINFORCING BARS SHALL BE NEW BILLET STEEL CONFORMING TO ASTM A-615, GRADE 60.
- 5. STANDARD PROTECTIVE COVER OF REINFORCING BARS UNLESS OTHERWISE NOTED SHALL BE:

WHERE CAST AGAINST DIRT OR FILL EXPOSED TO EARTH OF WEATHER	
COLUMNS	I I/ 2 IN.
SLABS AND WALLS	

- 6. ALL ACCESSORES SHALL BE IN ACCORDANCE WITH THE A.C.I. "IMMALAL OF STANDARD PRACTICE FOR DETAILING BENFORCED CONCRETE", A.C.I. #516 LATEST EDITION. ACCESSORES FOR EXPOSED CONCRETE SOFFITS SHALL HAVE PLASTIC CONTED FEET.
- VERTICAL CONSTRUCTION JOINTS IN FLOOR OR ROOF SLABS ARE TO BE AS SHOWN ON PLANS. NO HORIZONTAL JOINTS WILL BE PERMITTED IN SLABS OR BEAMS UNLESS OTHERWISE NOTED.
- 8. MANTAN A MINIMUM OF ONE PAR PLAWETER (PUT NOT LESS HAN) I")
  PERWEEN ALL BENFORCING PAPS (INCLUDING LAPS) ON ALL SLAPS,
  MANTAN A MINIMUM OF I-I-/ 2" BETWEEN PAPS IN COLUMNS, AND A
  MINIMUM OF I-I-/ 2" TIMES THE MAXIMUM COARSE ACCREGATE SIZE IN
  ALL CASES,
- 9. BARS SCHEDULED OR DETAILED "CONT." SHALL DE LAPPED 24 BAR DIAWETERS UNLESS OTHERWISE NOTED.
- IO. ALLOW FOR THE EQUIVALENT OF 5% OF REINFORCING FOR #4 BARS TO BE LISED AS RECURRED IN THE FIELD FOR SPECIAL CONDITIONS (LABOR FOR PLACING SAME TO BE INCLUDED).
- II. AT CORNERS AND "IT" INTERSECTIONS OF ALL FOUNDATION BEAMS, EXTEND 4 CORNER BARS EQUAL TO THE DETAILED STEEL IN THE ADJACENT BEAMS 2"-O" EACH WAY, 2 BARS TOP AND 2 BARS BOTTOM.
- 12. CONCRETE PLACED BY PUMPING SHALL MEET THE FOLLOWING REQUIREMENTS:
- a) COARSE AGGREGATE SHALL BE GRAPED FROM A MAXIMLIM OF
- a) CONSE ACCRECATE SHILL BE CREVED FROM A MANIMUM OF IT POWN.

  b) MANIMUM ALLOWARLE INDEACE IN CREMENT FACTOR SHULL BE 1/2 SACK PRE CIDEC WAS DEVER DEVENUE, MIX CESICAL.

  c) MANIMUM WASTE CREMENT FATOR SHULL BE 7/1/2 CALLONS FRE SACK OF CREMENT, E MORE WORKALIN'S IS EQUIPED. AN ADMINITURE MAY BE LEED.


  d) MANIMUM WASTE FATOR FOR THE ACCRECATES TO CONSES ACCRECATES SHULL NOT EXCEED 2/1/5.

  PERFER TO ACL. IT SOIL LATEST EDITION, SECTION BOO, FOR OTHER PUMPING REQUIREMENTS.


  D) IN IN CASE SHULL CONCRETE DE PLIMPED THROUGH AN ALUMINUM TIES.


#### FOUNDATION NOTES

- I. REMOVE AT LEAST 6 INCHES OF TOP SOIL, VEGETATION, DEBRIS, ETC., FROM THE PROPOSED BUILDING AREA TO A DISTANCE OF 5'-O'' OUTSIDE THE BUILDING LINE.
- 2. REWORK AND COMPACT THE TOP 6" OF THE EMPOSED SUBGRADE INDER ALL FLOORS AND WALST TO 95% (+ 5%) OF THE MAXIMUM DENISTY AT 22% TO +5% OF THE OPTIMUM NOTSINGE CONTENT, IN ACCORDANCE WITH TEST METHOD ASTM D-698, PRIOR TO PLACEMENT
- WITH THE REQUIREMENTS BELOW.
- SELECT FILL, WHEN PROPERLY SLAKED AND TESTED BY STANDARD LABORATORY METHODS, SHALL MEET THE FOLLOWING REQUIREMENTS:
- a) LIQUID LIMIT SHALL BE LESS THAN OR EQUAL TO 37.
- b) PLASTICITY INDEX SHALL BE LESS THAN 17 AND GREATER THAN 5.
- c) SHALL CONTAIN NO ORGANIC MATERIAL.
- a) SHALL CONTAIN NO STONES LARGER THAN 2 INCHES.
- SAMPLES OF PROPOSED SELECTFILL SHALL BE FLRNISHED TO THE TESTING LABORATORY 7 DAYS PRIOR TO INSTALLATION TO PERMIT TIME FOR SPECIFICATION COMPLIANCE INSPECTION AND APPROVAL.

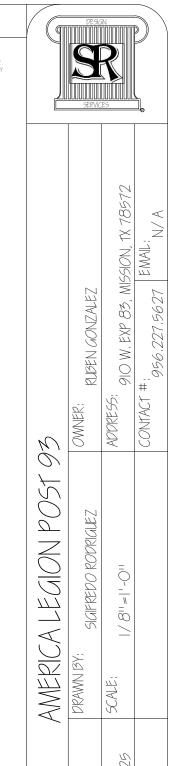

 $\overline{C}_{j}$ 

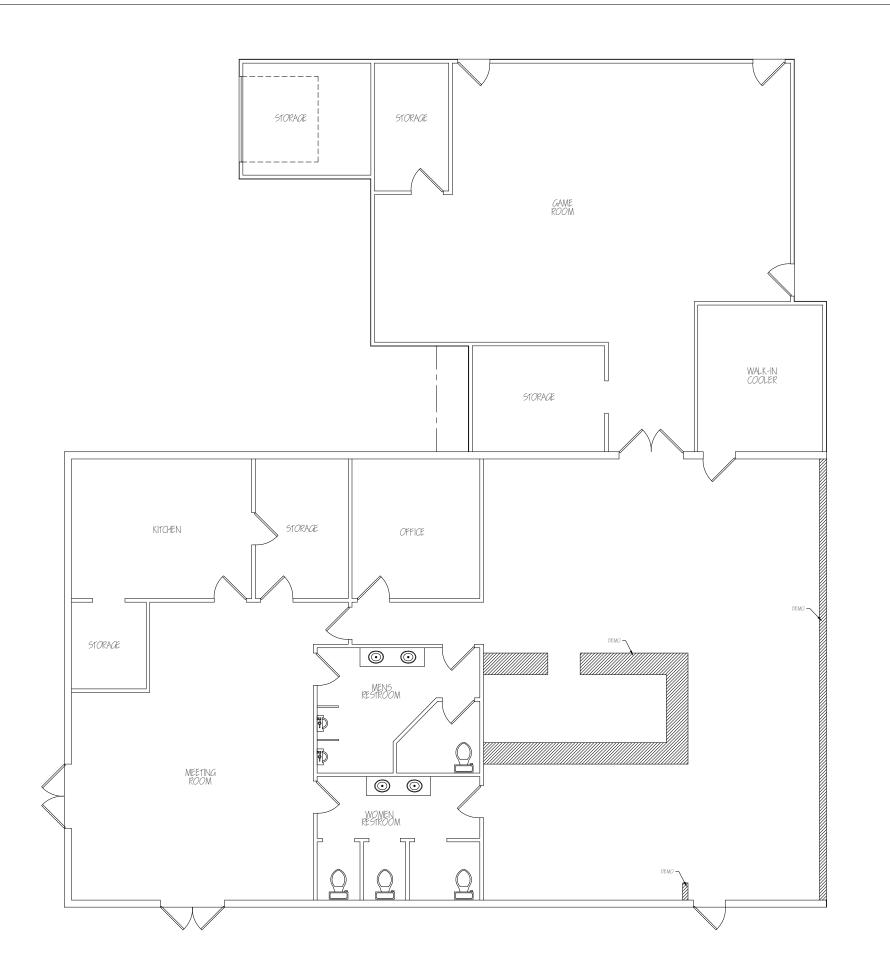

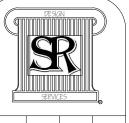

93	OWNER; RUBEN GONZALEZ	ADDRESS; 910 W. EXP 83, MISSION, TX 78572	CONTACT #: 656 227,5627 EMAIL: N. A
AMERICA LEGION POST 93	DRAWN BY; SIGIFREDO RODRIGUEZ	SCALE;  /8"= '-0"	
PROJECT TITLE:	CONTRACTOR; T.B.A	DATE : JUNE 12, 2025	

DEMOLITION PLAN SCALE: 1/4" = 1'-0"

